


AREA OF THE FLOORING:

DETERMINATIONS OF BASEMENT PLAN				
Room#	Function	M ²	Flooring	Notes
0.01	LANDING,STAIRCASE	13.328	CERAMIC TILES	30X60
0.02	ELEVATOR	2.76	EPOXY LAYER	3mm
0.03	BOILER ROOM	15.39	CONCRETE CLADDING	10mm
0.04	CORRIDOR	4.125	EPOXY LAYER	3mm
0.05	GARAGE	565.975	BAUTCHKA PARKING FINISHES	


TOTAL AREA OF THE GROUND FLOOR = 601.478 m²

EXPLANATION OF THE SYMBOLS:

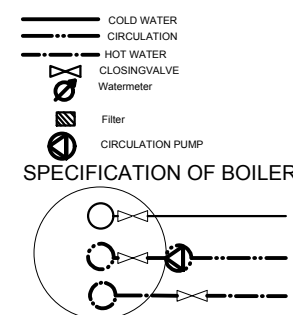

±0,000 = 278,55 m ASL

DEVELOPED BY: Bc.M. Faeyz Yosufi	CONSULTANT: Ing . Miroslav Urban, Ph.D.	CONTROLLED: Ing . Miroslav Urban, Ph.D.	
DREW BY: Bc.M. Faeyz Yosufi	CUSTOMER: Faculty of Civil Engineerinf Czech technical University In Prague		
General Purpose: Multifunctional building		PARE:	
Attachment name: Water supply system, basement plan		Scale: 1:50	
		Drawing No. 05	

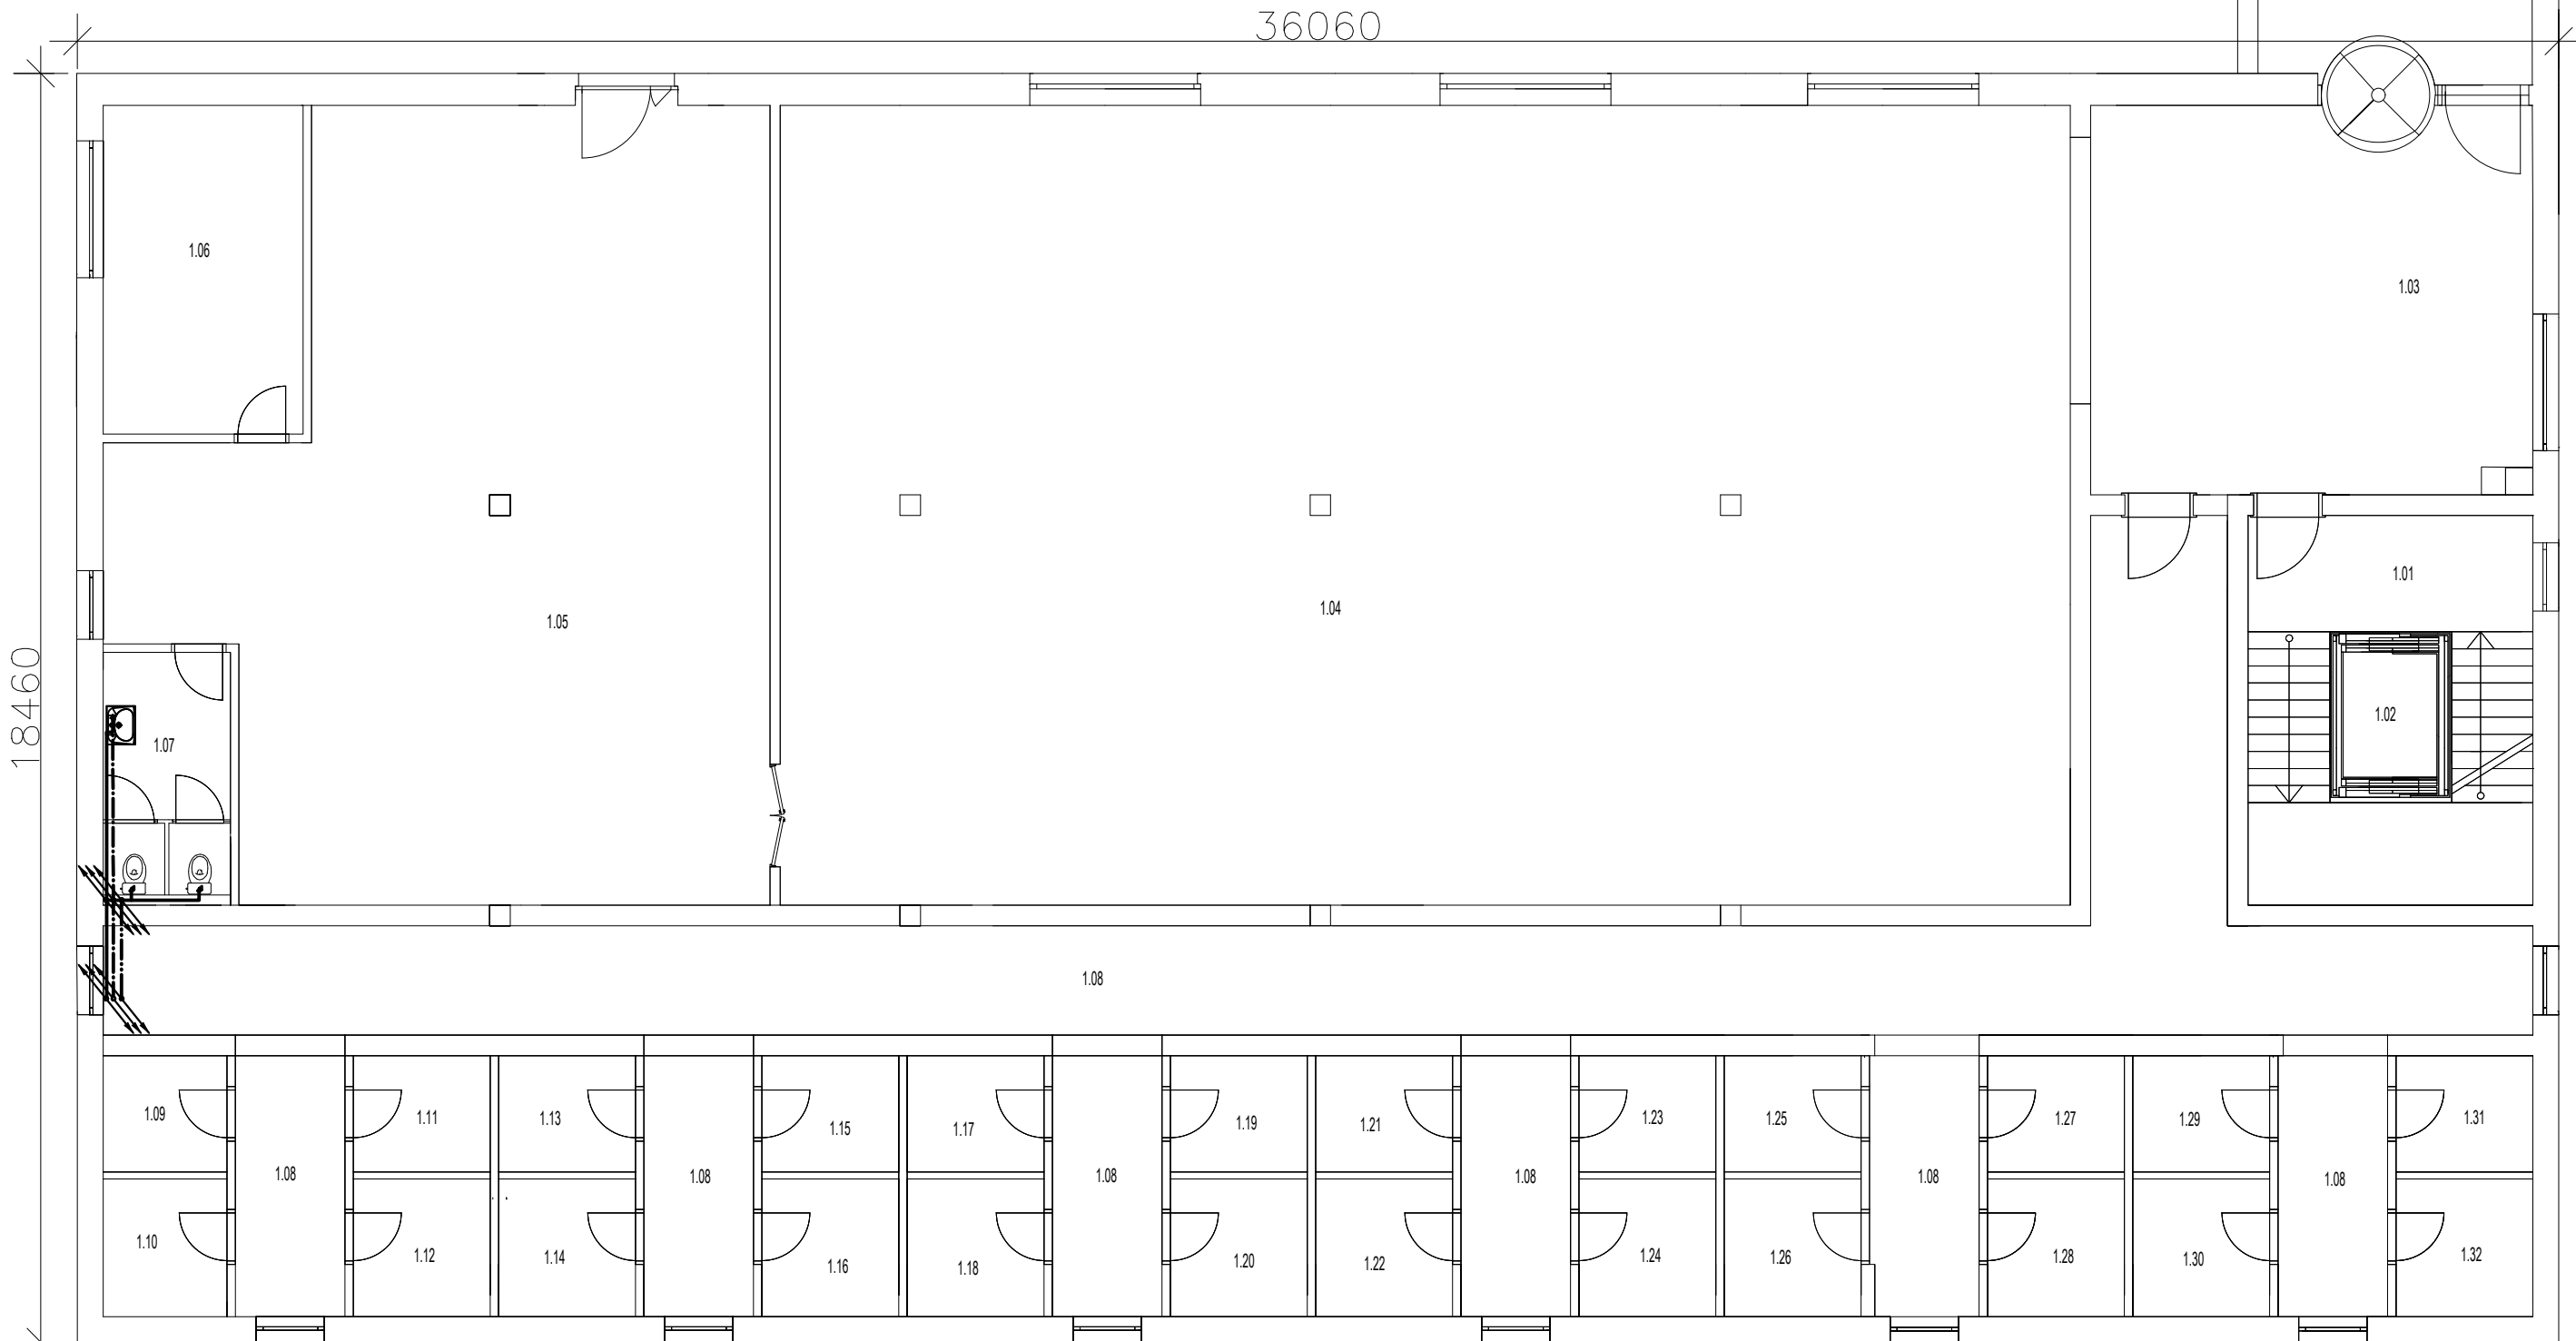

AREA OF THE FLOORING:


Room#	Function	m ²	Flooring	Notes
1.01	LANDING,STAIRCASE	13.328	CERAMIC TILES	30X60
1.02	ELEVATOR	2.76	EPOXY LAYER	3mm
1.03	MAIN INTERFACE	36.822	CERAMIC TILES	30X60
1.04	SUPER MARKET	220.779	CERAMIC TILES	30X60
1.05	STORAGE	92.60	CERAMIC TILES	30X60
1.06	OFFICE	14.016	PVC wooden plank	4mm, 2.2kg/m ²
1.07	WASH BASIN&TOILET	6.63	CERAMIC TILES	22.5X45
1.08	MAIN CORRIDOR	65.656	EPOXY LAYER	3mm
1.08	STORAGE CORRIDOR	6.104	EPOXY LAYER	3mm
1.09	STORAGE	3.077	EPOXY LAYER	3mm
1.10	STORAGE	3.847	EPOXY LAYER	3mm
1.11	STORAGE	3.4	EPOXY LAYER	3mm
1.12	STORAGE	4.03	EPOXY LAYER	3mm
1.13	STORAGE	3.4	EPOXY LAYER	3mm
1.14	STORAGE	4.03	EPOXY LAYER	3mm
1.15	STORAGE	3.4	EPOXY LAYER	3mm
1.16	STORAGE	4.03	EPOXY LAYER	3mm
1.17	STORAGE	3.4	EPOXY LAYER	3mm

AREA OF THE FLOORING:


Room#	Function	m ²	Flooring	Notes
1.18	STORAGE	4.03	EPOXY LAYER	3mm
1.19	STORAGE	3.40	EPOXY LAYER	3mm
1.20	STORAGE	4.03	EPOXY LAYER	3mm
1.21	STORAGE	3.40	EPOXY LAYER	3mm
1.22	STORAGE	4.03	EPOXY LAYER	3mm
1.23	STORAGE	3.40	EPOXY LAYER	3mm
1.24	STORAGE	4.03	EPOXY LAYER	3mm
1.25	STORAGE	3.40	EPOXY LAYER	3mm
1.26	STORAGE	4.03	EPOXY LAYER	3mm
1.27	STORAGE	3.40	EPOXY LAYER	3mm
1.28	STORAGE	4.03	EPOXY LAYER	3mm
1.29	STORAGE	3.40	EPOXY LAYER	3mm
1.30	STORAGE	4.03	EPOXY LAYER	3mm
1.31	STORAGE	3.40	EPOXY LAYER	3mm
1.32	STORAGE	4.03	EPOXY LAYER	3mm

TOTAL AREA OF THE GROUND FLOOR = 528.259 m²


LEGEND:

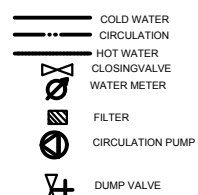

SPECIFICATION OF BOILER

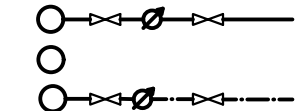


SYMBOLS:

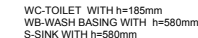

±0,000 = 278,55 m ASL

DEVELOPED BY: Bc.M. Faeyz Yosufi	CONSULTANT: Ing . Miroslav Urban, Ph.D.	CONTROLLED: Ing . Miroslav Urban, Ph.D.
DREW BY: Bc.M. Faeyz Yosufi	CUSTOMER: Faculty of Civil Engineerinf Czech technical University In Prague	
General Purpose: Multifunctional building		PARE:
Attachment name: Water supply system,, ground floor plan		Scale: 1:50
Format:	2XA4	
Date:	13.10.2019	
Purpose	building permit	
Archive Issues	----	
Drawing No. 06		



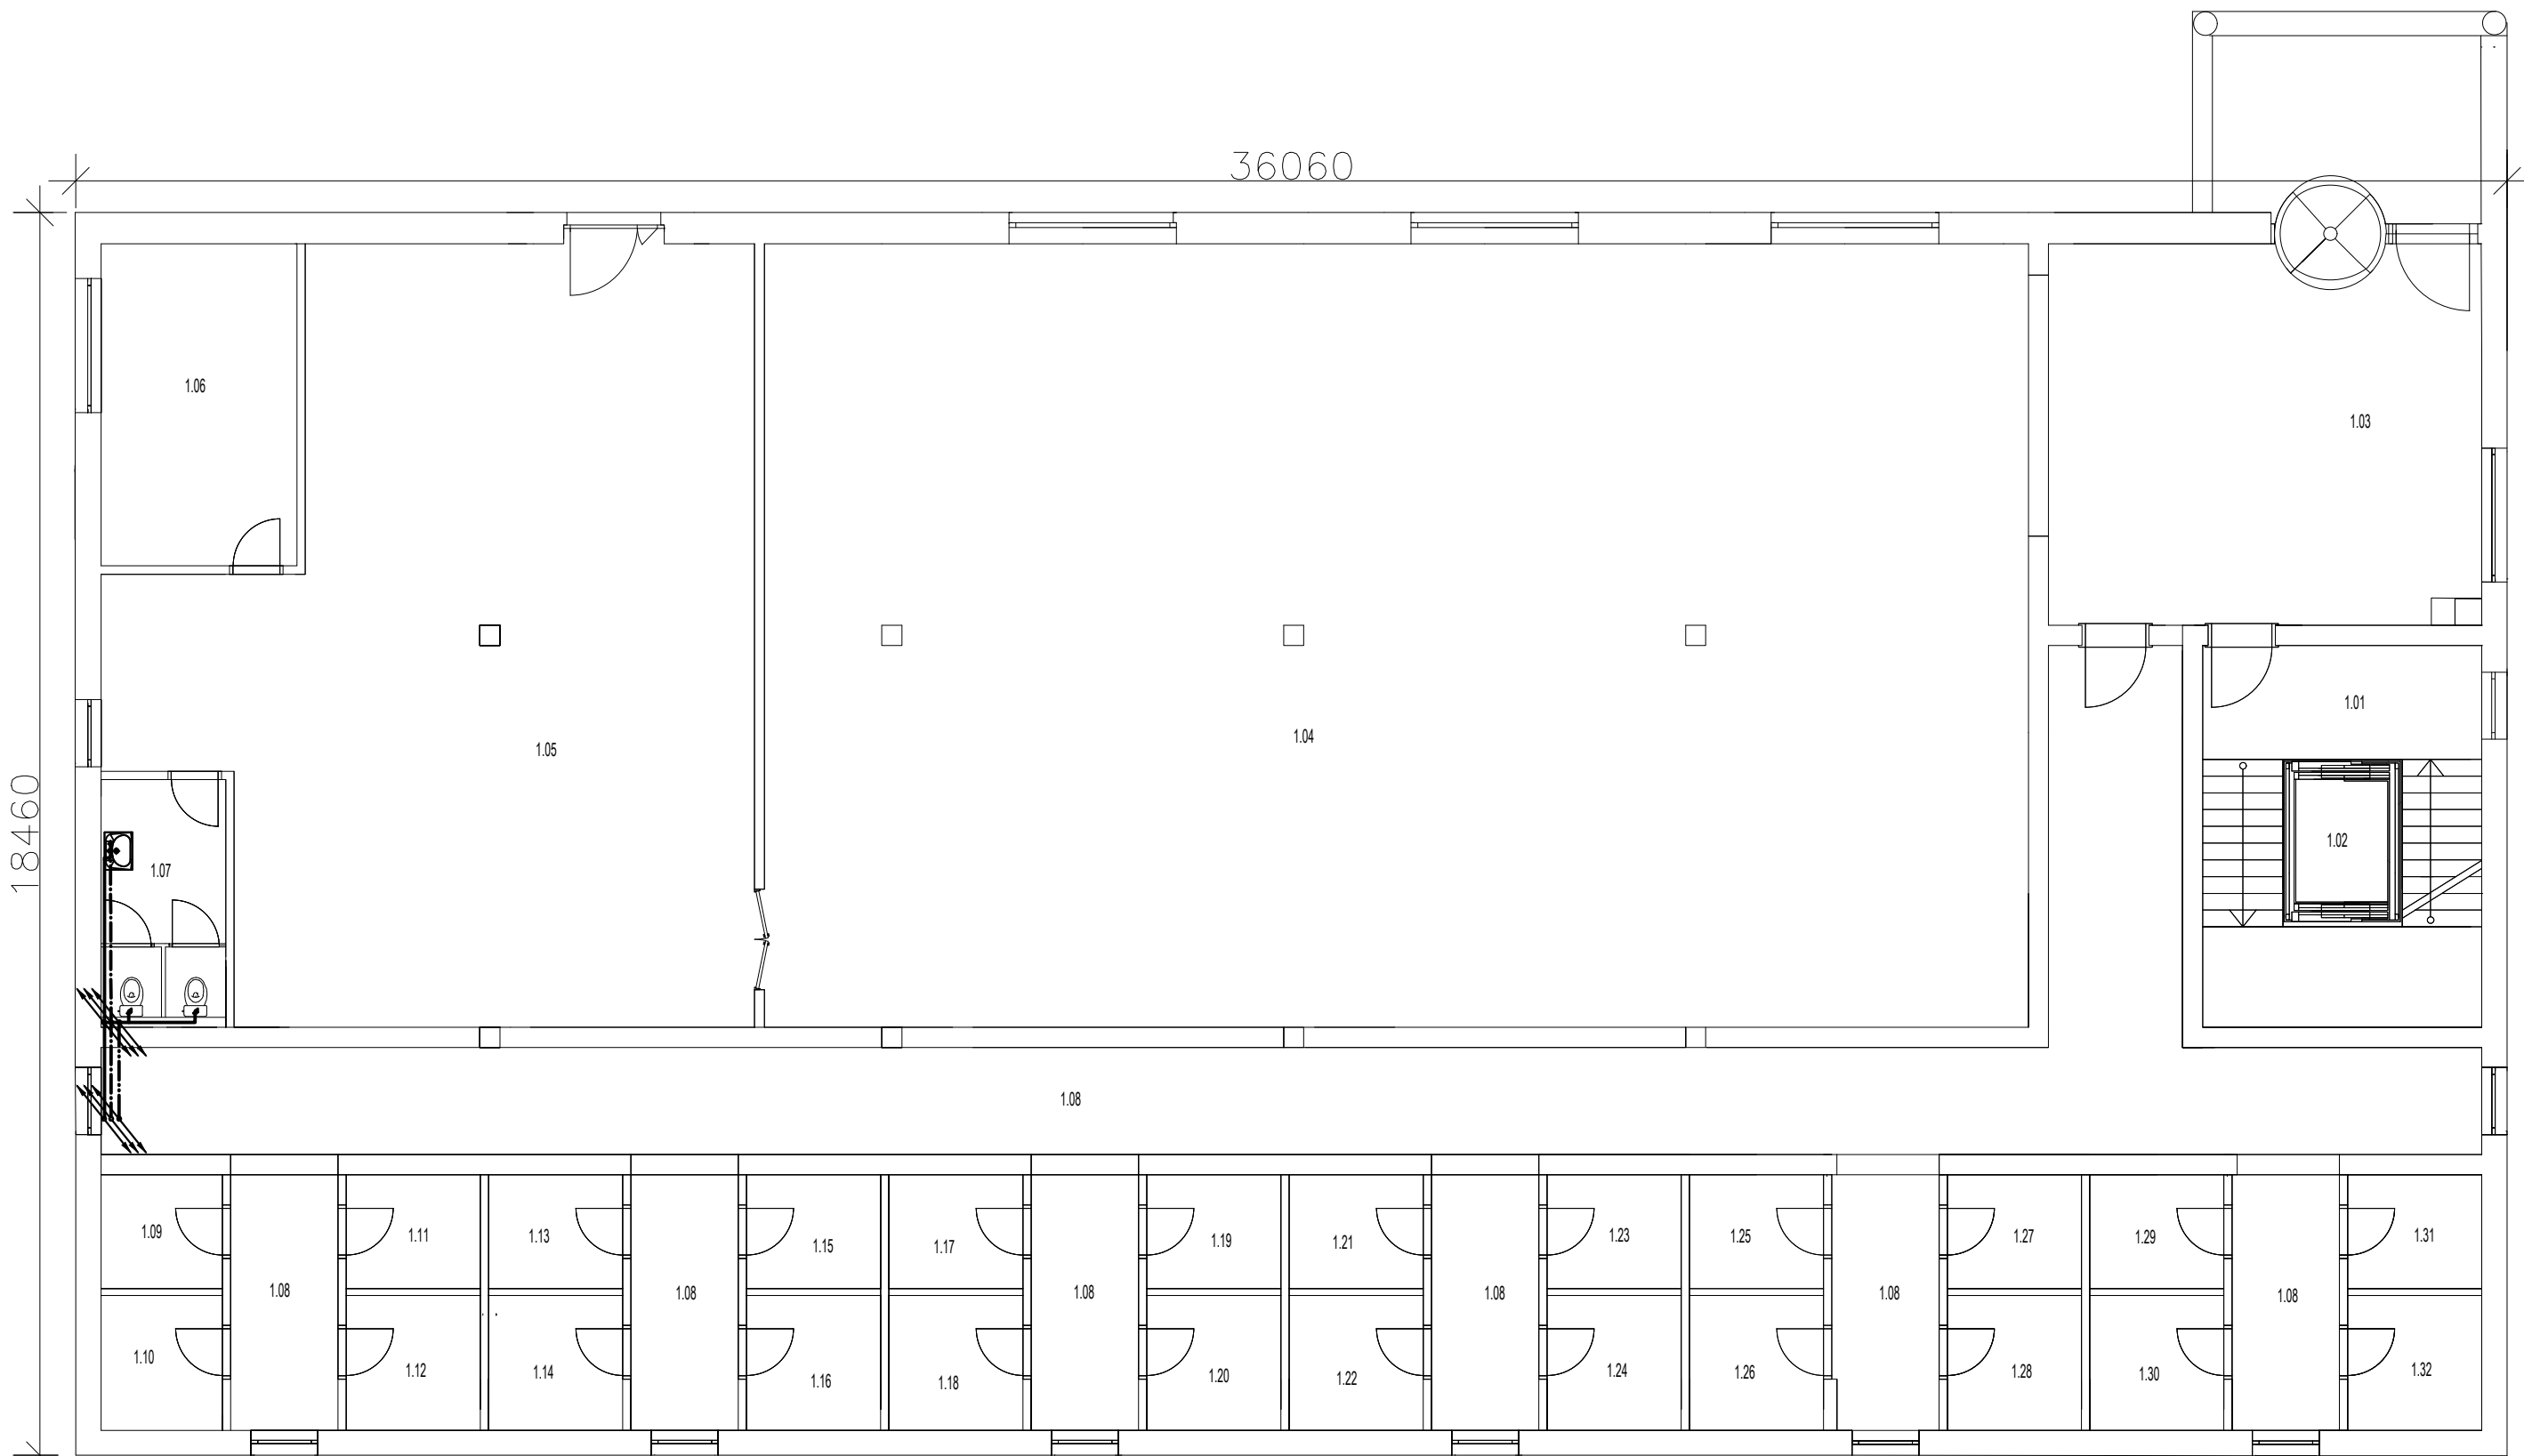

AREA OF THE FLOORING:


Room#	Function	m ²	Flooring	Notes
1.01	LANDING,STAIRCASE	13.328	CERAMIC TILES	30X60
1.02	ELEVATOR	2.76	EPOXY LAYER	3mm
1.03	MAIN INTERFACE	36.822	CERAMIC TILES	30X60
1.04	SUPER MARKET	220.779	CERAMIC TILES	30X60
1.05	STORAGE	92.60	CERAMIC TILES	30X60
1.06	OFFICE	14.016	PVC wooden plank	4mm, 2.2kg/m ²
1.07	WASH BASIN&TOILET	6.63	CERAMIC TILES	22.5X45
1.08	MAIN CORRIDOR	65.656	EPOXY LAYER	3mm
1.08	STORAGE CORRIDOR	6.104	EPOXY LAYER	3mm
1.09	STORAGE	3.077	EPOXY LAYER	3mm
1.10	STORAGE	3.847	EPOXY LAYER	3mm
1.11	STORAGE	3.4	EPOXY LAYER	3mm
1.12	STORAGE	4.03	EPOXY LAYER	3mm
1.13	STORAGE	3.4	EPOXY LAYER	3mm
1.14	STORAGE	4.03	EPOXY LAYER	3mm
1.15	STORAGE	3.4	EPOXY LAYER	3mm
1.16	STORAGE	4.03	EPOXY LAYER	3mm
1.17	STORAGE	3.4	EPOXY LAYER	3mm

AREA OF THE FLOORING:


Room#	Function	m ²	Flooring	Notes
1.18	STORAGE	4.03	EPOXY LAYER	3mm
1.19	STORAGE	3.40	EPOXY LAYER	3mm
1.20	STORAGE	4.03	EPOXY LAYER	3mm
1.21	STORAGE	3.40	EPOXY LAYER	3mm
1.22	STORAGE	4.03	EPOXY LAYER	3mm
1.23	STORAGE	3.40	EPOXY LAYER	3mm
1.24	STORAGE	4.03	EPOXY LAYER	3mm
1.25	STORAGE	3.40	EPOXY LAYER	3mm
1.26	STORAGE	4.03	EPOXY LAYER	3mm
1.27	STORAGE	3.40	EPOXY LAYER	3mm
1.28	STORAGE	4.03	EPOXY LAYER	3mm
1.29	STORAGE	3.40	EPOXY LAYER	3mm
1.30	STORAGE	4.03	EPOXY LAYER	3mm
1.31	STORAGE	3.40	EPOXY LAYER	3mm
1.32	STORAGE	4.03	EPOXY LAYER	3mm

TOTAL AREA OF THE GROUND FLOOR = 528.259 m²


LEGEND:

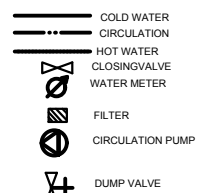

SPECIFICATION OF BOILER

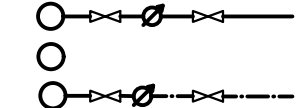


SYMBOLS:

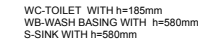

±0,000 = 278,55 m ASL

DEVELOPED BY: Bc.M. Faeyz Yosufi	CONSULTANT: Ing . Miroslav Urban, Ph.D.	CONTROLLED: Ing . Miroslav Urban, Ph.D.
DREW BY: Bc.M. Faeyz Yosufi	CUSTOMER: Faculty of Civil Engineerinf Czech technical University In Prague	
General Purpose: Multifunctional building		PARE:
Attachment name: Water supply system,, ground floor plan		Scale: 1:50
Format:	2XA4	
Date:	13.10.2019	
Purpose	building permit	
Archive Issues	----	
Drawing No. 06		



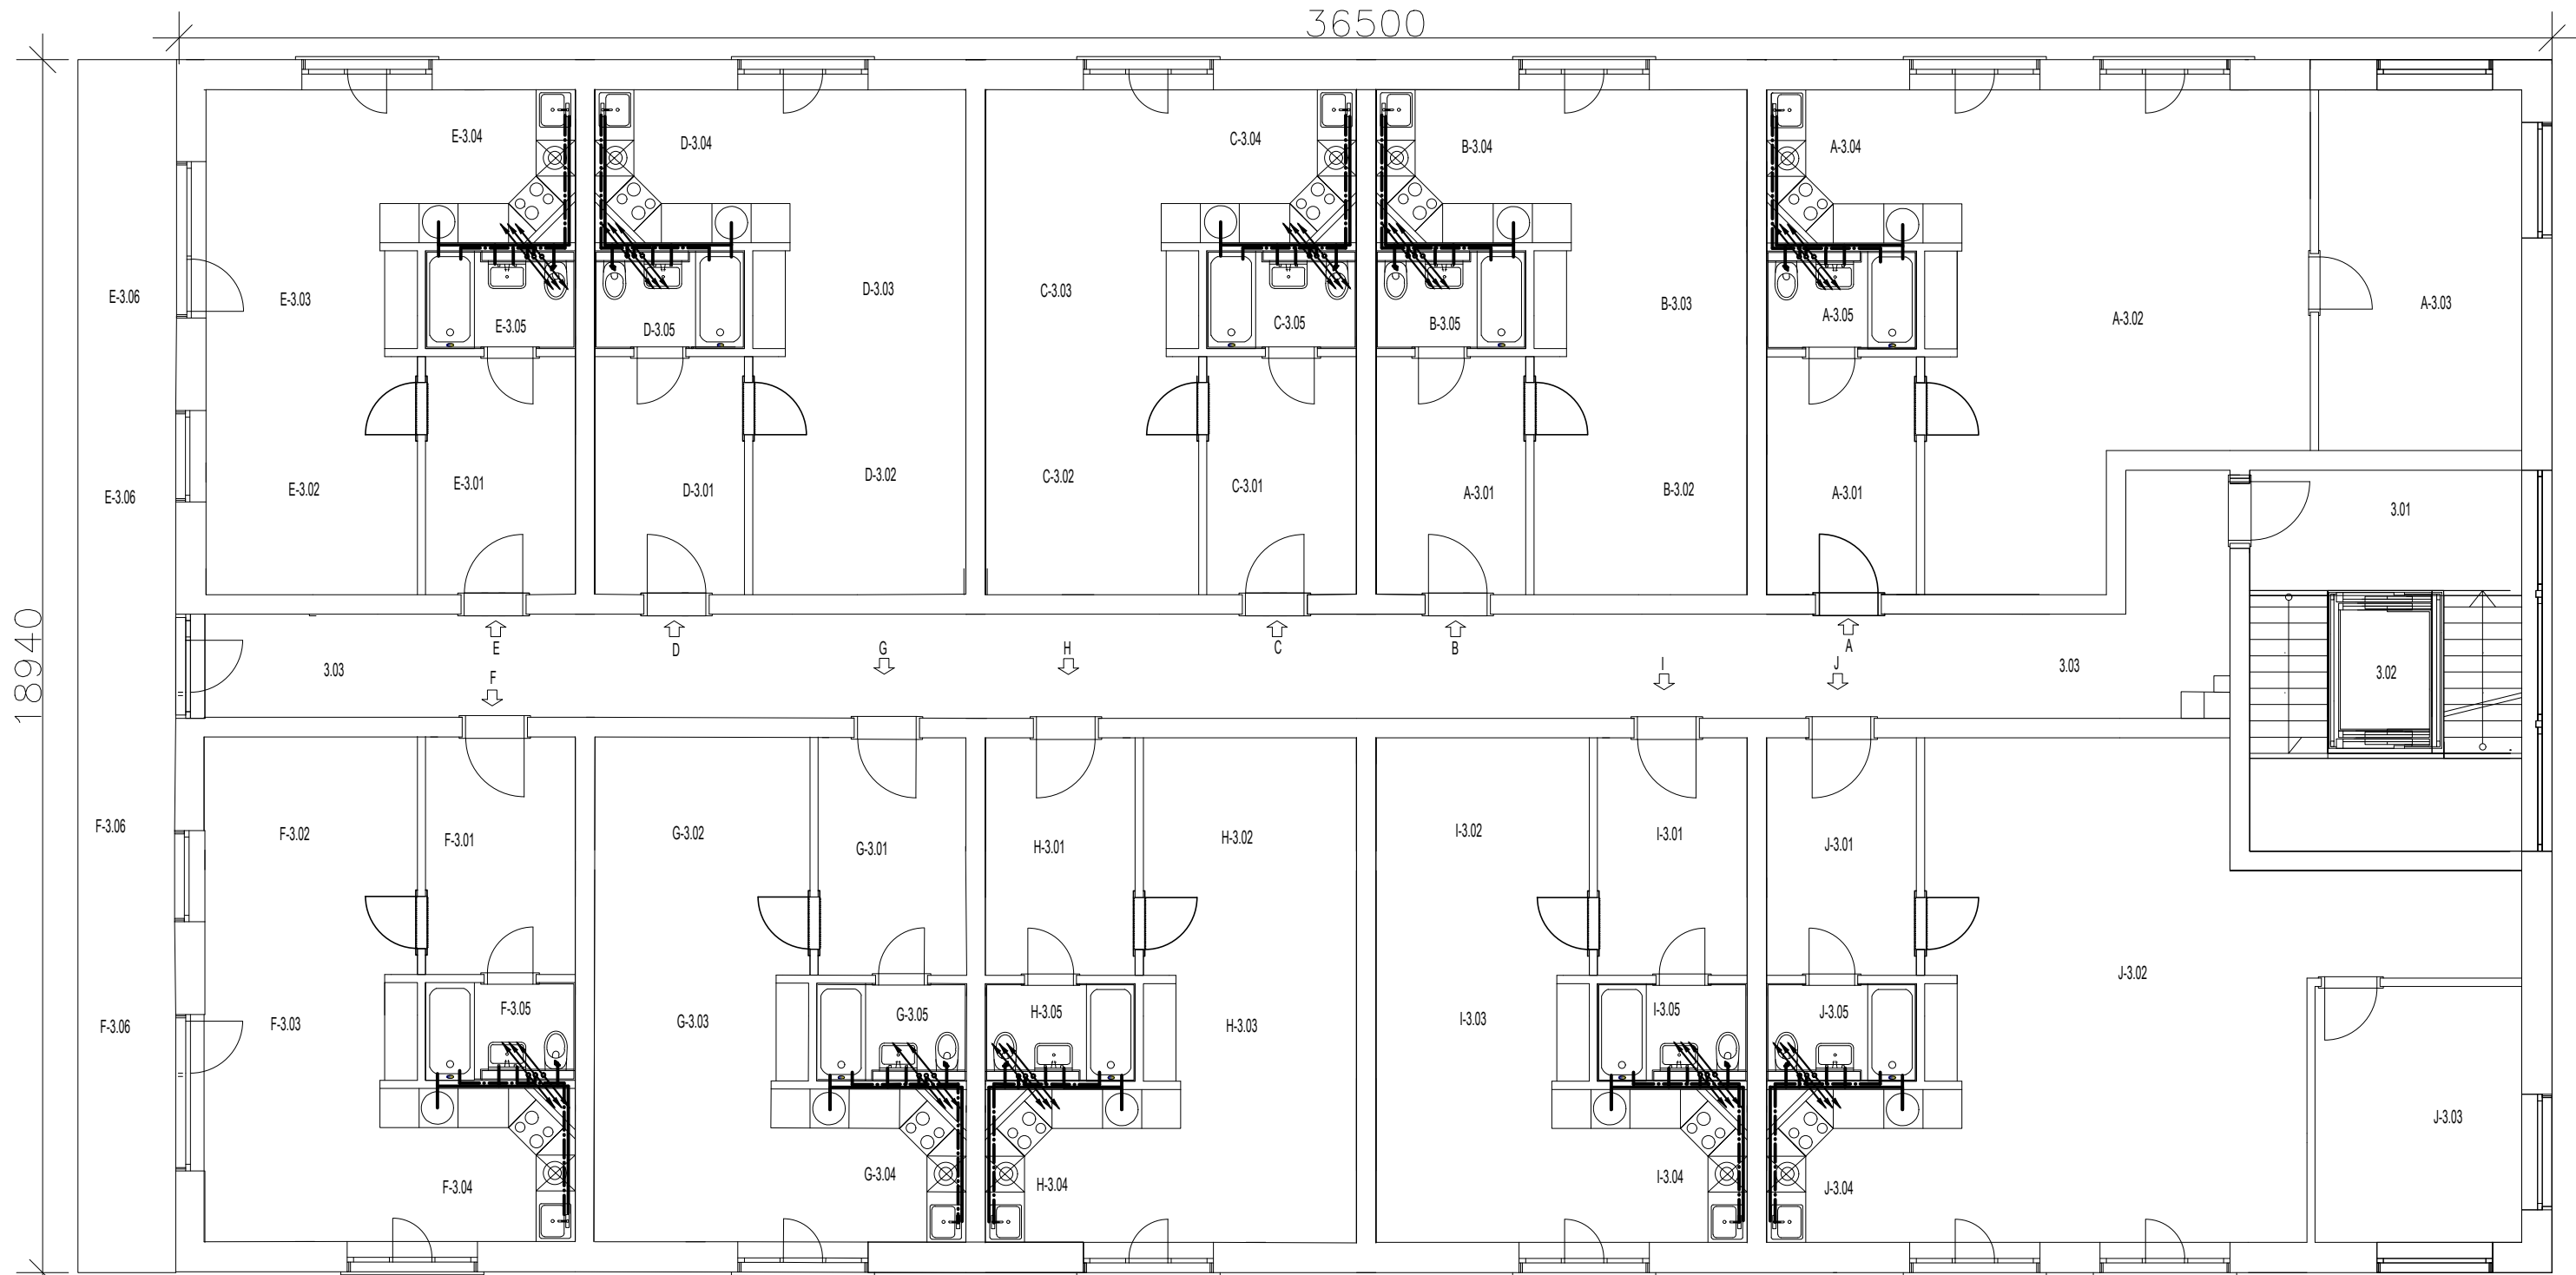

AREA OF THE FLOORING:

Room#	Function	M ²	Flooring	Notes
3. 01	LANDING,STAIRCASE	13.328	CERAMIC TILES	30X60
3. 02	ELEVATOR	2.76	EPOXY LAYER	3mm
3. 03	MAIN CORRIDOR	53.304	EPOXY LAYER	3mm
A-3.01	CORRIDOR	8.40	PVC wooden plank	4mm, 2.2kg/m ²
A-3.02	LIVING ROOM	27.45	PVC wooden plank	4mm, 2.2kg/m ²
A-3.03	BED ROOM	17.30	PVC wooden plank	4mm, 2.2kg/m ²
A-3.04	KITCHEN + DINNING ROOM	13.64	PVC wooden plank	4mm, 2.2kg/m ²
A-3.05	BATH-ROOM	3.11	CERAMIC TILES	22.5X45
TOTAL AREA OF THE APARTMENT L = 139.292 m ²				

Room#	Function	M ²	Flooring	Notes
B-3.01	CORRIDOR	8.40	PVC wooden plank	4mm, 2.2kg/m ²
B-3.02	LIVING ROOM	10.47	PVC wooden plank	4mm, 2.2kg/m ²
B-3.03	BED ROOM	8.040	PVC wooden plank	4mm, 2.2kg/m ²
B-3.04	KITCHEN + DINNING ROOM	9.040	PVC wooden plank	4mm, 2.2kg/m ²
B-3.05	BATH-ROOM	3.11	CERAMIC TILES	22.5X45
TOTAL AREA OF THE APARTMENT L = 39.06 m ²				

Room#	Function	M ²	Flooring	Notes
C-3.01	CORRIDOR	8.40	PVC wooden plank	4mm, 2.2kg/m ²
C-3.02	LIVING ROOM	10.47	PVC wooden plank	4mm, 2.2kg/m ²
C-3.03	BED ROOM	8.040	PVC wooden plank	4mm, 2.2kg/m ²
C-3.04	KITCHEN + DINNING ROOM	9.040	PVC wooden plank	4mm, 2.2kg/m ²
C-3.05	BATH-ROOM	3.11	CERAMIC TILES	22.5X45
TOTAL AREA OF THE APARTMENT L = 39.06 m ²				

Room#	Function	M ²	Flooring	Notes
E-3.01	CORRIDOR	8.40	PVC wooden plank	4mm, 2.2kg/m ²
E-3.02	LIVING ROOM	10.47	PVC wooden plank	4mm, 2.2kg/m ²
E-3.03	BED ROOM	8.040	PVC wooden plank	4mm, 2.2kg/m ²
E-3.04	KITCHEN + DINNING ROOM	9.040	PVC wooden plank	4mm, 2.2kg/m ²
E-3.05	BATH-ROOM	3.11	CERAMIC TILES	22.5X45
E-3.06	BALCONY	14.12	CERAMIC TILES	30X60
TOTAL AREA OF THE APARTMENT L = 53.18 m ²				

Room#	Function	M ²	Flooring	Notes
F-3.01	CORRIDOR	8.40	PVC wooden plank	4mm, 2.2kg/m ²
F-3.02	LIVING ROOM	10.47	PVC wooden plank	4mm, 2.2kg/m ²
F-3.03	BED ROOM	8.040	PVC wooden plank	4mm, 2.2kg/m ²
F-3.04	KITCHEN + DINNING ROOM	9.040	PVC wooden plank	4mm, 2.2kg/m ²
F-3.05	BATH-ROOM	3.11	CERAMIC TILES	22.5X45
F-3.06	BALCONY	14.12	CERAMIC TILES	30X60
TOTAL AREA OF THE APARTMENT L = 53.18 m ²				


Room#	Function	M ²	Flooring	Notes
G-3.01	CORRIDOR	8.40	PVC wooden plank	4mm, 2.2kg/m ²
G-3.02	LIVING ROOM	10.47	PVC wooden plank	4mm, 2.2kg/m ²
G-3.03	BED ROOM	8.040	PVC wooden plank	4mm, 2.2kg/m ²
G-3.04	KITCHEN + DINNING ROOM	9.040	PVC wooden plank	4mm, 2.2kg/m ²
G-3.05	BATH-ROOM	3.11	CERAMIC TILES	22.5X45
TOTAL AREA OF THE APARTMENT L = 39.06 m ²				

Room#	Function	M ²	Flooring	Notes
I-3.01	CORRIDOR	8.40	PVC wooden plank	4mm, 2.2kg/m ²
I-3.02	LIVING ROOM	10.47	PVC wooden plank	4mm, 2.2kg/m ²
I-3.03	BED ROOM	8.040	PVC wooden plank	4mm, 2.2kg/m ²
I-3.04	KITCHEN + DINNING ROOM	9.040	PVC wooden plank	4mm, 2.2kg/m ²
I-3.05	BATH-ROOM	3.11	CERAMIC TILES	22.5X45
TOTAL AREA OF THE APARTMENT L = 39.06 m ²				


Room#	Function	M ²	Flooring	Notes
J-3.01	CORRIDOR	8.40	PVC wooden plank	4mm, 2.2kg/m ²
J-3.02	LIVING ROOM	36.80	PVC wooden plank	4mm, 2.2kg/m ²
J-3.03	BED ROOM	12.48	PVC wooden plank	4mm, 2.2kg/m ²
J-3.04	KITCHEN + DINNING ROOM	9.040	PVC wooden plank	4mm, 2.2kg/m ²
J-3.05	BATH-ROOM	3.11	CERAMIC TILES	22.5X45
TOTAL AREA OF THE APARTMENT L = 39.06 m ²				

Room#	Function	M ²	Flooring	Notes
H-3.01	CORRIDOR	8.40	PVC wooden plank	4mm, 2.2kg/m ²
H-3.02	LIVING ROOM	10.47	PVC wooden plank	4mm, 2.2kg/m ²
H-3.03	BED ROOM	8.040	PVC wooden plank	4mm, 2.2kg/m ²
H-3.04	KITCHEN + DINNING ROOM	9.040	PVC wooden plank	4mm, 2.2kg/m ²
H-3.05	BATH-ROOM	3.11	CERAMIC TILES	22.5X45
TOTAL AREA OF THE APARTMENT L = 39.06 m ²				


LEGEND:

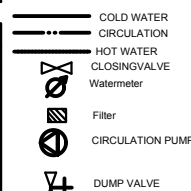

SPECIFICATION OF BOILER

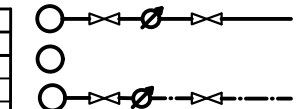

SYMBOLS:

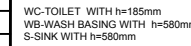

±0,000 = 278,55 m ASL

DEVELOPED BY: Bc.M. Faeyz Yosufi	CONSULTANT: Ing. Miroslav Urban, Ph.D.	CONTROLLED: Ing. Miroslav Urban, Ph.D.	ČVUT
DREW BY: Bc.M. Faeyz Yosufi	CUSTOMER: Faculty of Civil Engineering Czech technical University In Prague		
General Purpose: Multifunctional building			PARE:
Attachment name: Water supply system,, typical floor plans			Scale: 1:50
			Drawing No. 08

3 - 5 FLOOR PLANS: + 16,60m

